

# ALTERATIONS & ADDITIONS TO AN EXISTING DWELLING AND PROPOSED ATTACHED DWELLING (NO SUBDIVISION)

**CLIENT:** BILLY McMAUGH **STATUS:** DETAIL DESIGN

**LOT No:** 206 **DP No:** 1236728

STREET NAME: 92 ANGUS DRIVE, FAILFORD 2430

CWC JOB #: A5682








#### GENERIC | TYPICAL KEY, LEGEND AND ABBREVIATIONS FOR COLLINS W COLLINS ARCHITECTURAL PLANS

THESE NOTES MUST BE READ AND UNDERSTOOD BY ALL INVOLVED IN THE PROJECT. THIS INCLUDES (but is not limited to): OWNER, BUILDER, SUB-CONTRACTORS, CONSULTANTS, RENOVATORS, OPERATORS, MAINTAINERS, DEMOLISHERS. PLEASE USE THIS IN CONJUNCTION WITH ALL DRAWING SHEETS AND VIEWS CONTAINED FORTHWITH IN THIS PLAN SET. REVISED JANUARY 2023

#### SYMBOLS AND LINES

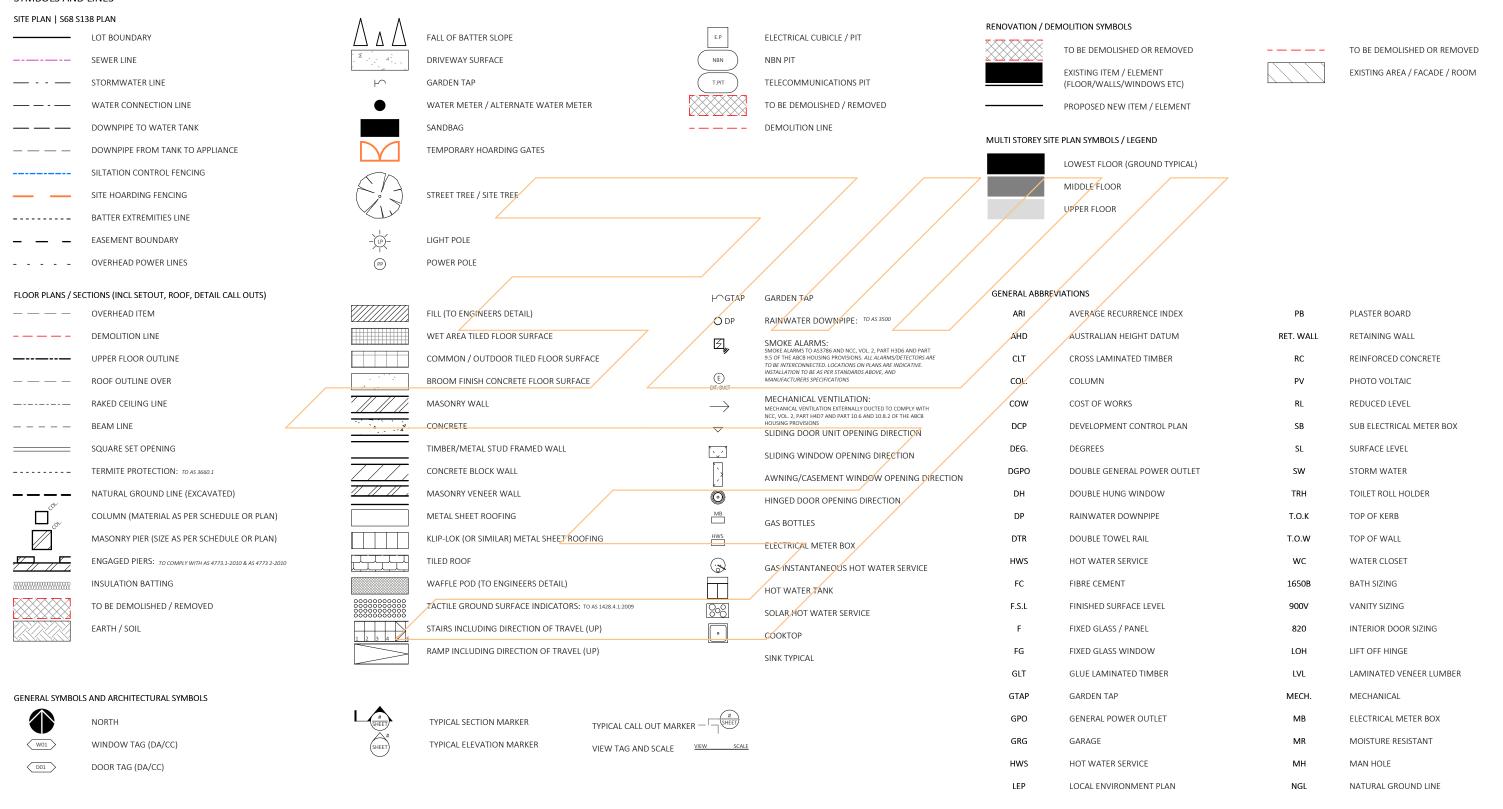






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PROJECT: ALTERATIONS & ADDITIONS TO AN	EXISTING DWELLING	LEGENDS		DRAWIN	G REVISION + NOTES		
AND PROPOSED ATTACHED DWELLI	ING (NO SUBDIVISION)			Date:	Revision:	Issue:	Drawn:
STATUS: DETAIL DESIGN	SHEET: 1 OF 21	SCALE:	1:100	07.09.23	INITIAL ISSUE	А	AE
LOT No: 206 DP No: 1236728	SHEET. 1 OF 21			20.05.24	FINAL CONCEPT	K	JS
STREET: 92 ANGUS DRIVE, FAILFORD 2430		SHEET SIZE:	A3	19.06.24	FINAL CONCEPT - REVISED	L	JS
STREET: 32 / WOOS BIWE, 17 WEI GIB 2 150		START DATE:	09.01.2023	22.07.24	PRELIMINARY DA ISSUE	М	JS
0.1515				10.09.24	SHED UPDATES	N	JS
CLIENT: BILLY McMAUGH		DWG No:	A5682	14.10.24	DA ISSUE	P	JS
ot Arcade Targe NSW 2430 T. 03	6583 4411				WWW COLLINSWCO	LINS CO	OM ALL

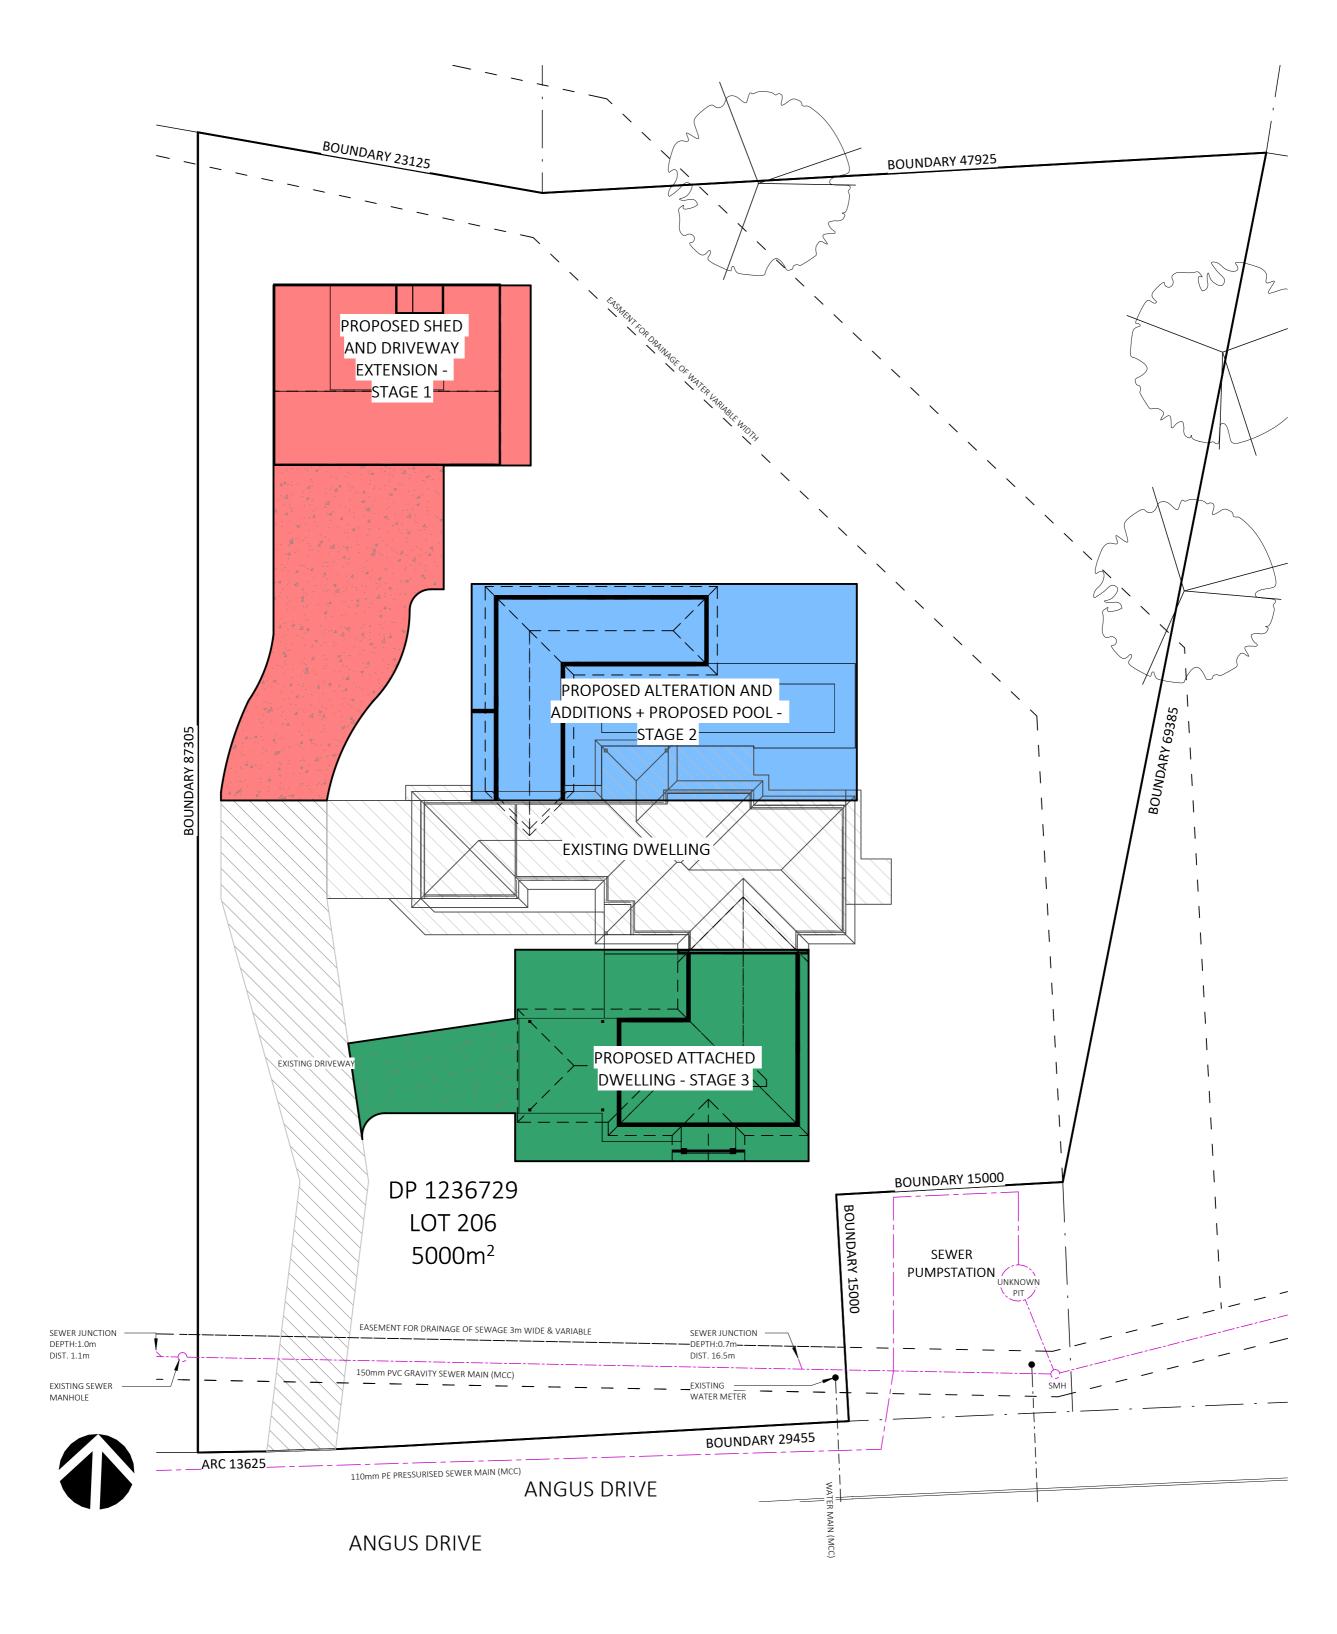

SITE PLAN - STAGING

1:250



**BUSHFIRE NOTES:** 

BAL - N/A

PORTAL SPATIAL VIEWER MAPPING


BASIX NOTES:


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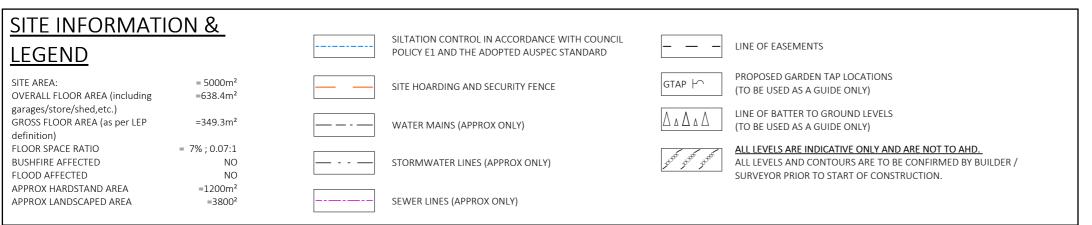
#### GENERAL PLAN SET NOTES:

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#### DA ISSUE ONLY





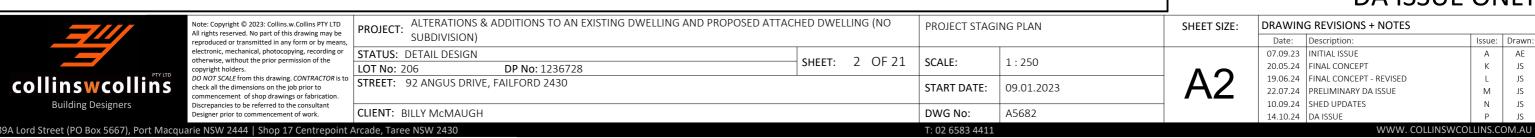

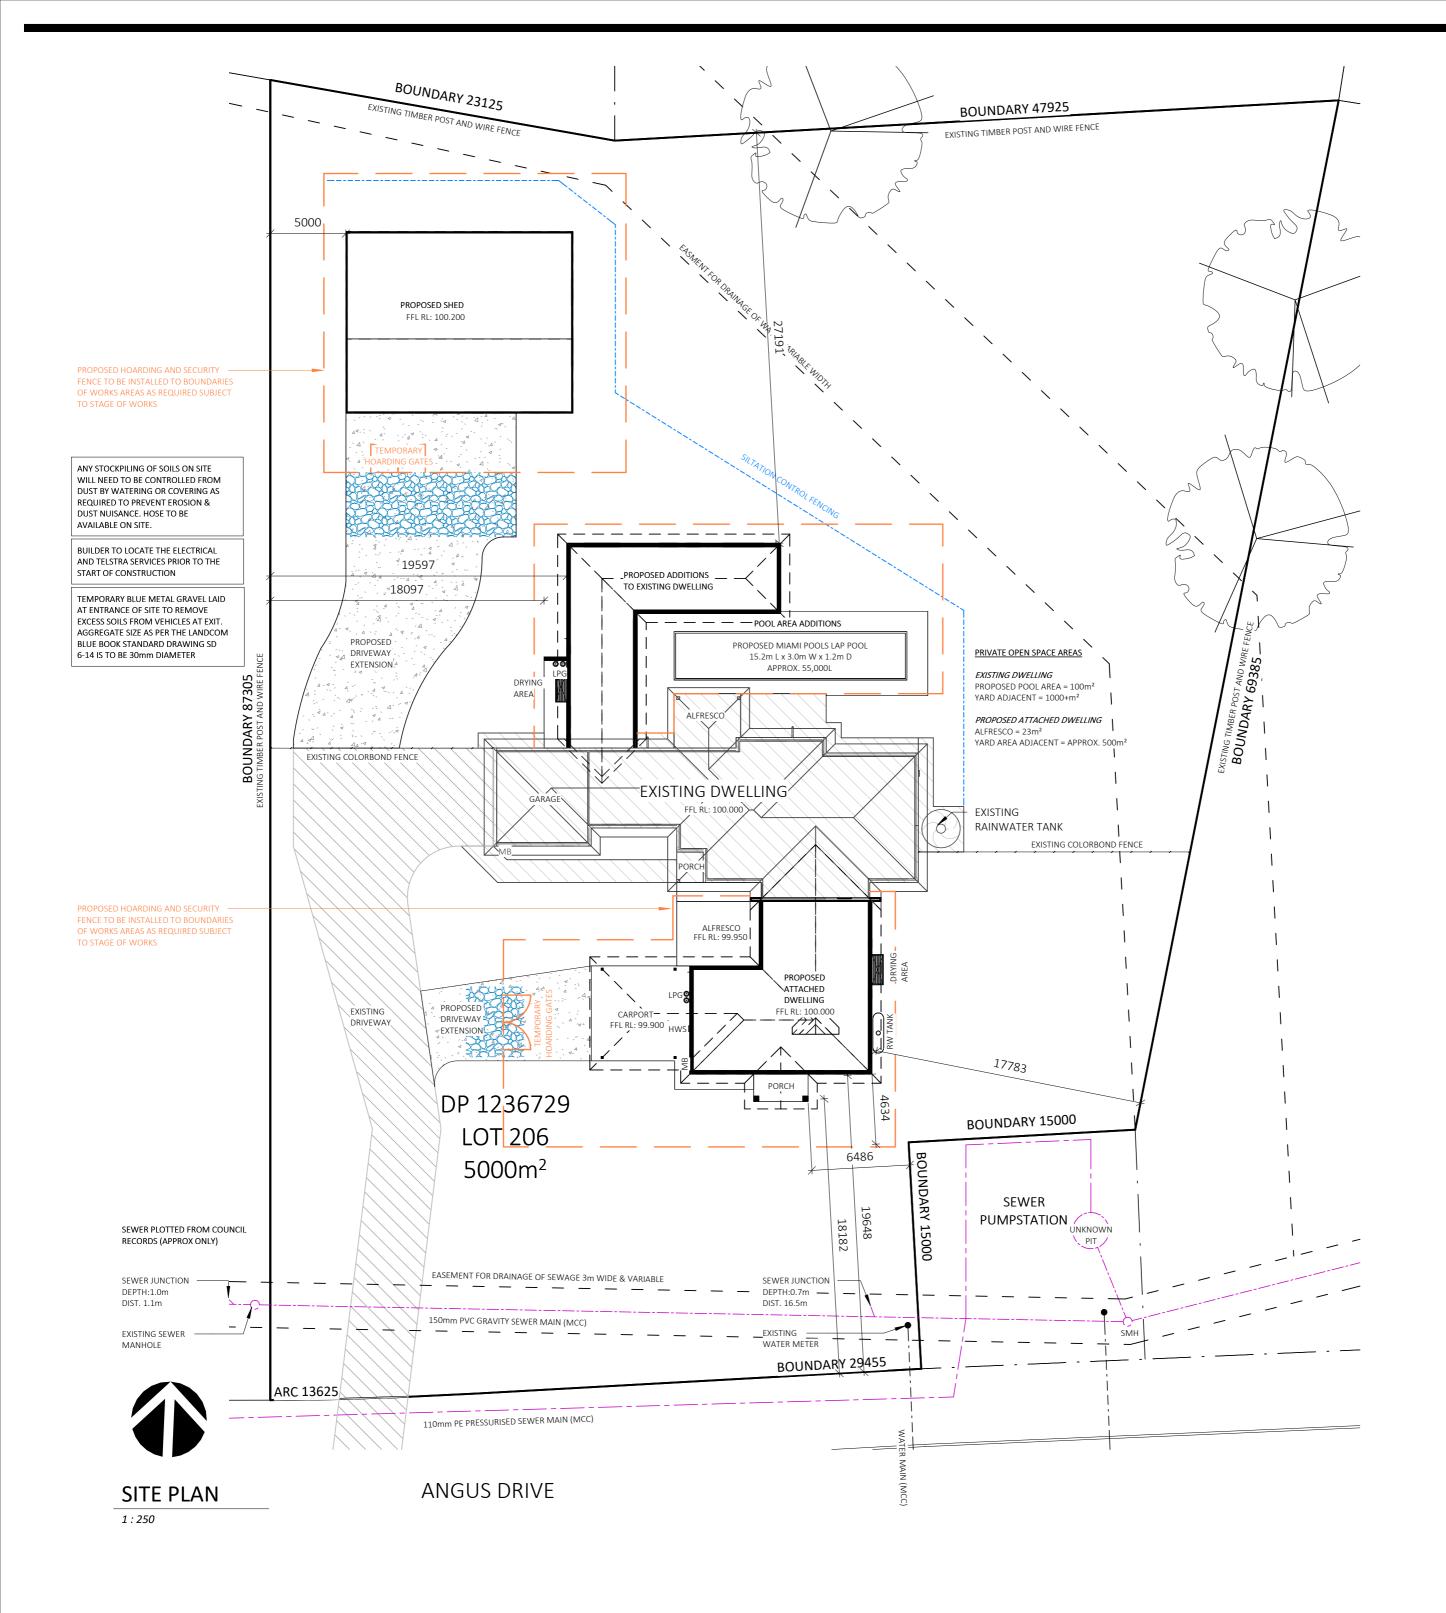

#### **BUSHFIRE NOTES:**

BAL - N/A

PORTAL SPATIAL VIEWER MAPPING

#### **BASIX NOTES:**

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<b>Building Designers</b>	ı
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89A Lord Street (PO Box 5667), Port Macquarie NSW 2444 | Shop 17 Centrepoint Arcade, Taree NSW 2430

CLIENT: BILLY McMAUGH


ALTERATIONS & ADDITIONS TO AN EXISTING DWELLING AND PROPOSED ATTACHED DWELLING (NO PROJECT: SUBDIVISION) STATUS: DETAIL DESIGN LOT No: 206 DP No: 1236728 STREET: 92 ANGUS DRIVE, FAILFORD 2430

SITE PLAN SHEET: 3 OF 21 SCALE: As indicated START DATE: 09.01.2023 DWG No: A5682

DRAWING REVISIONS + NOTES SHEET SIZE: Date: Description: Issue: Drawn: 07.09.23 INITIAL ISSUE 20.05.24 FINAL CONCEPT JS 19.06.24 FINAL CONCEPT - REVISED JS М JS


22.07.24 PRELIMINARY DA ISSUE 10.09.24 SHED UPDATES 14.10.24 DA ISSUE T: 02 6583 441

AREAS - ROOF AREAS - PROPOSED				
NAME	AREA			
EXISTING ROOF	291.9 m²			
PERGOLA ROOF	23.5 m²			
PROPOSED DWELLING ROOF	190.5 m²			
PROPOSED ROOF ADDITIONS	134.8 m²			
PROPOSED SHED ROOF	180.0 m²			
TOTAL	820.6 m <sup>2</sup>			

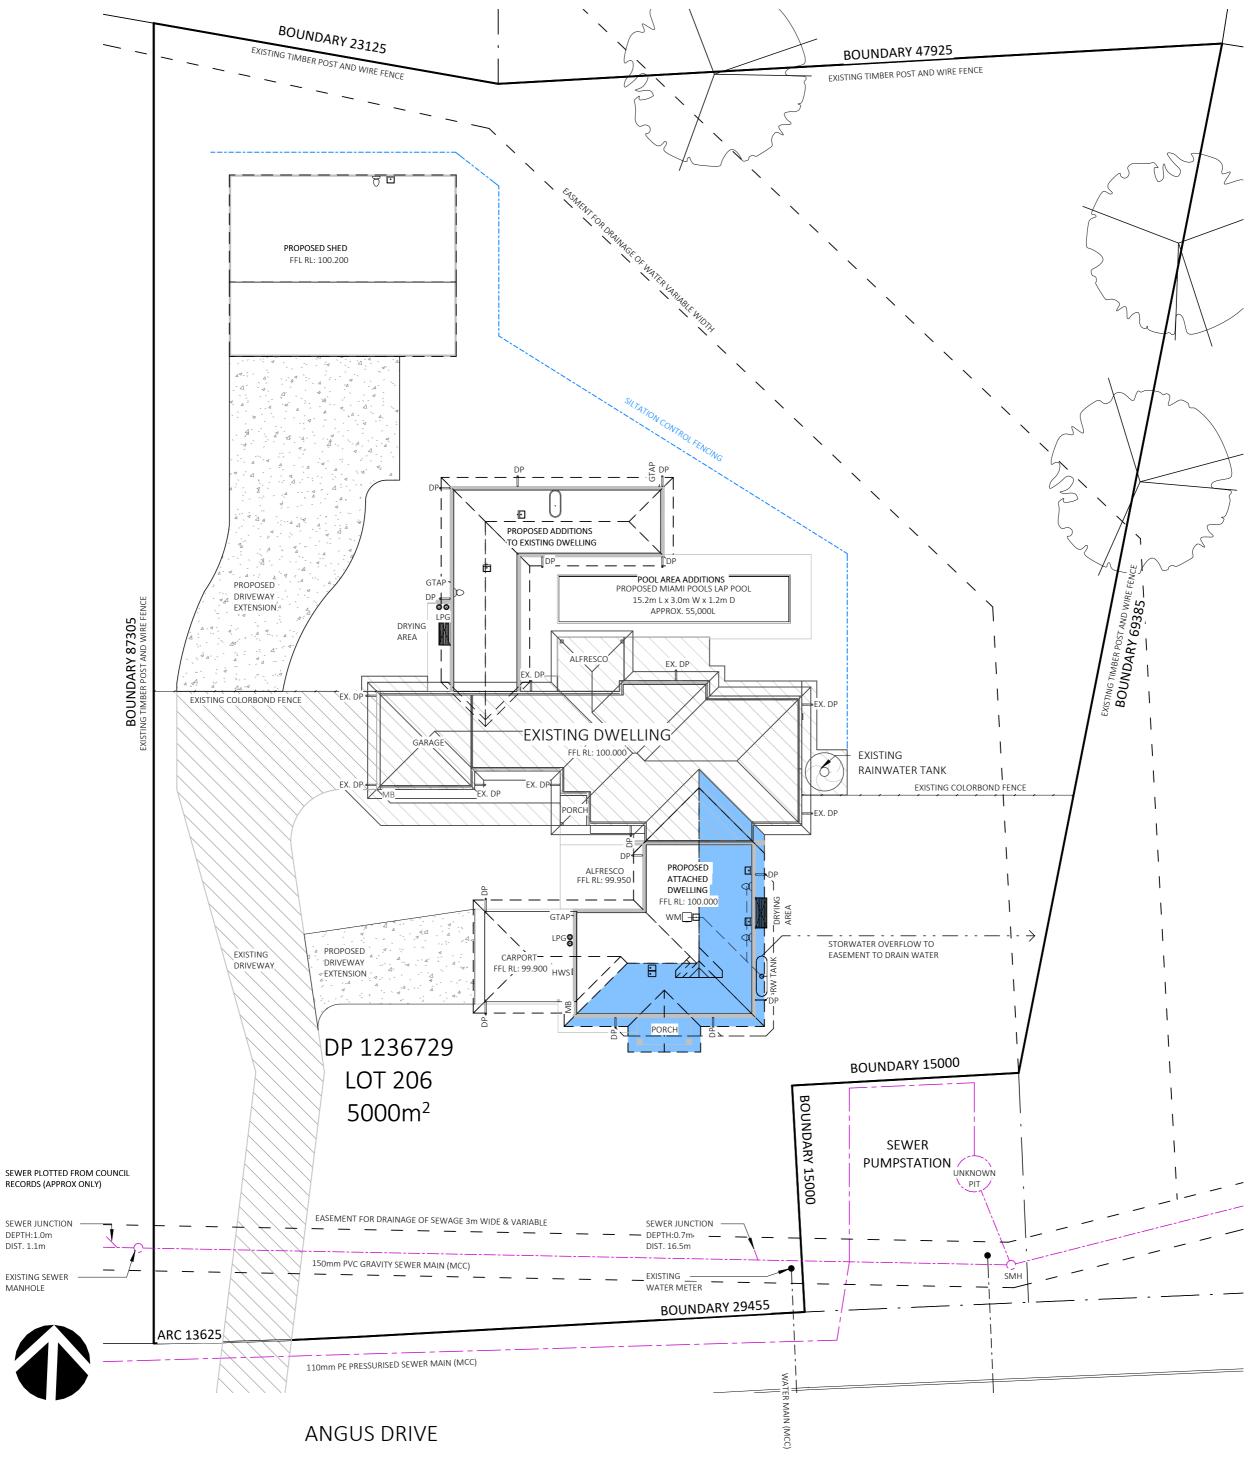

# **S68 SERVICES - SITE PLAN**

1:250

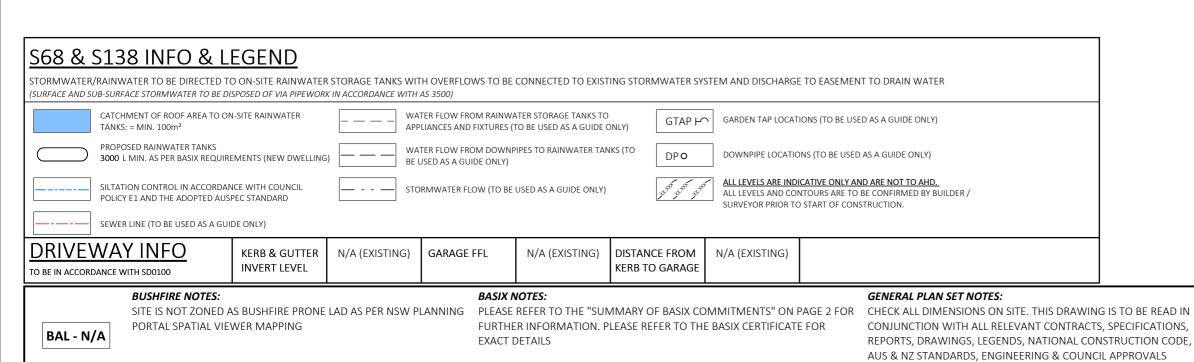



# DA ISSUE ONLY




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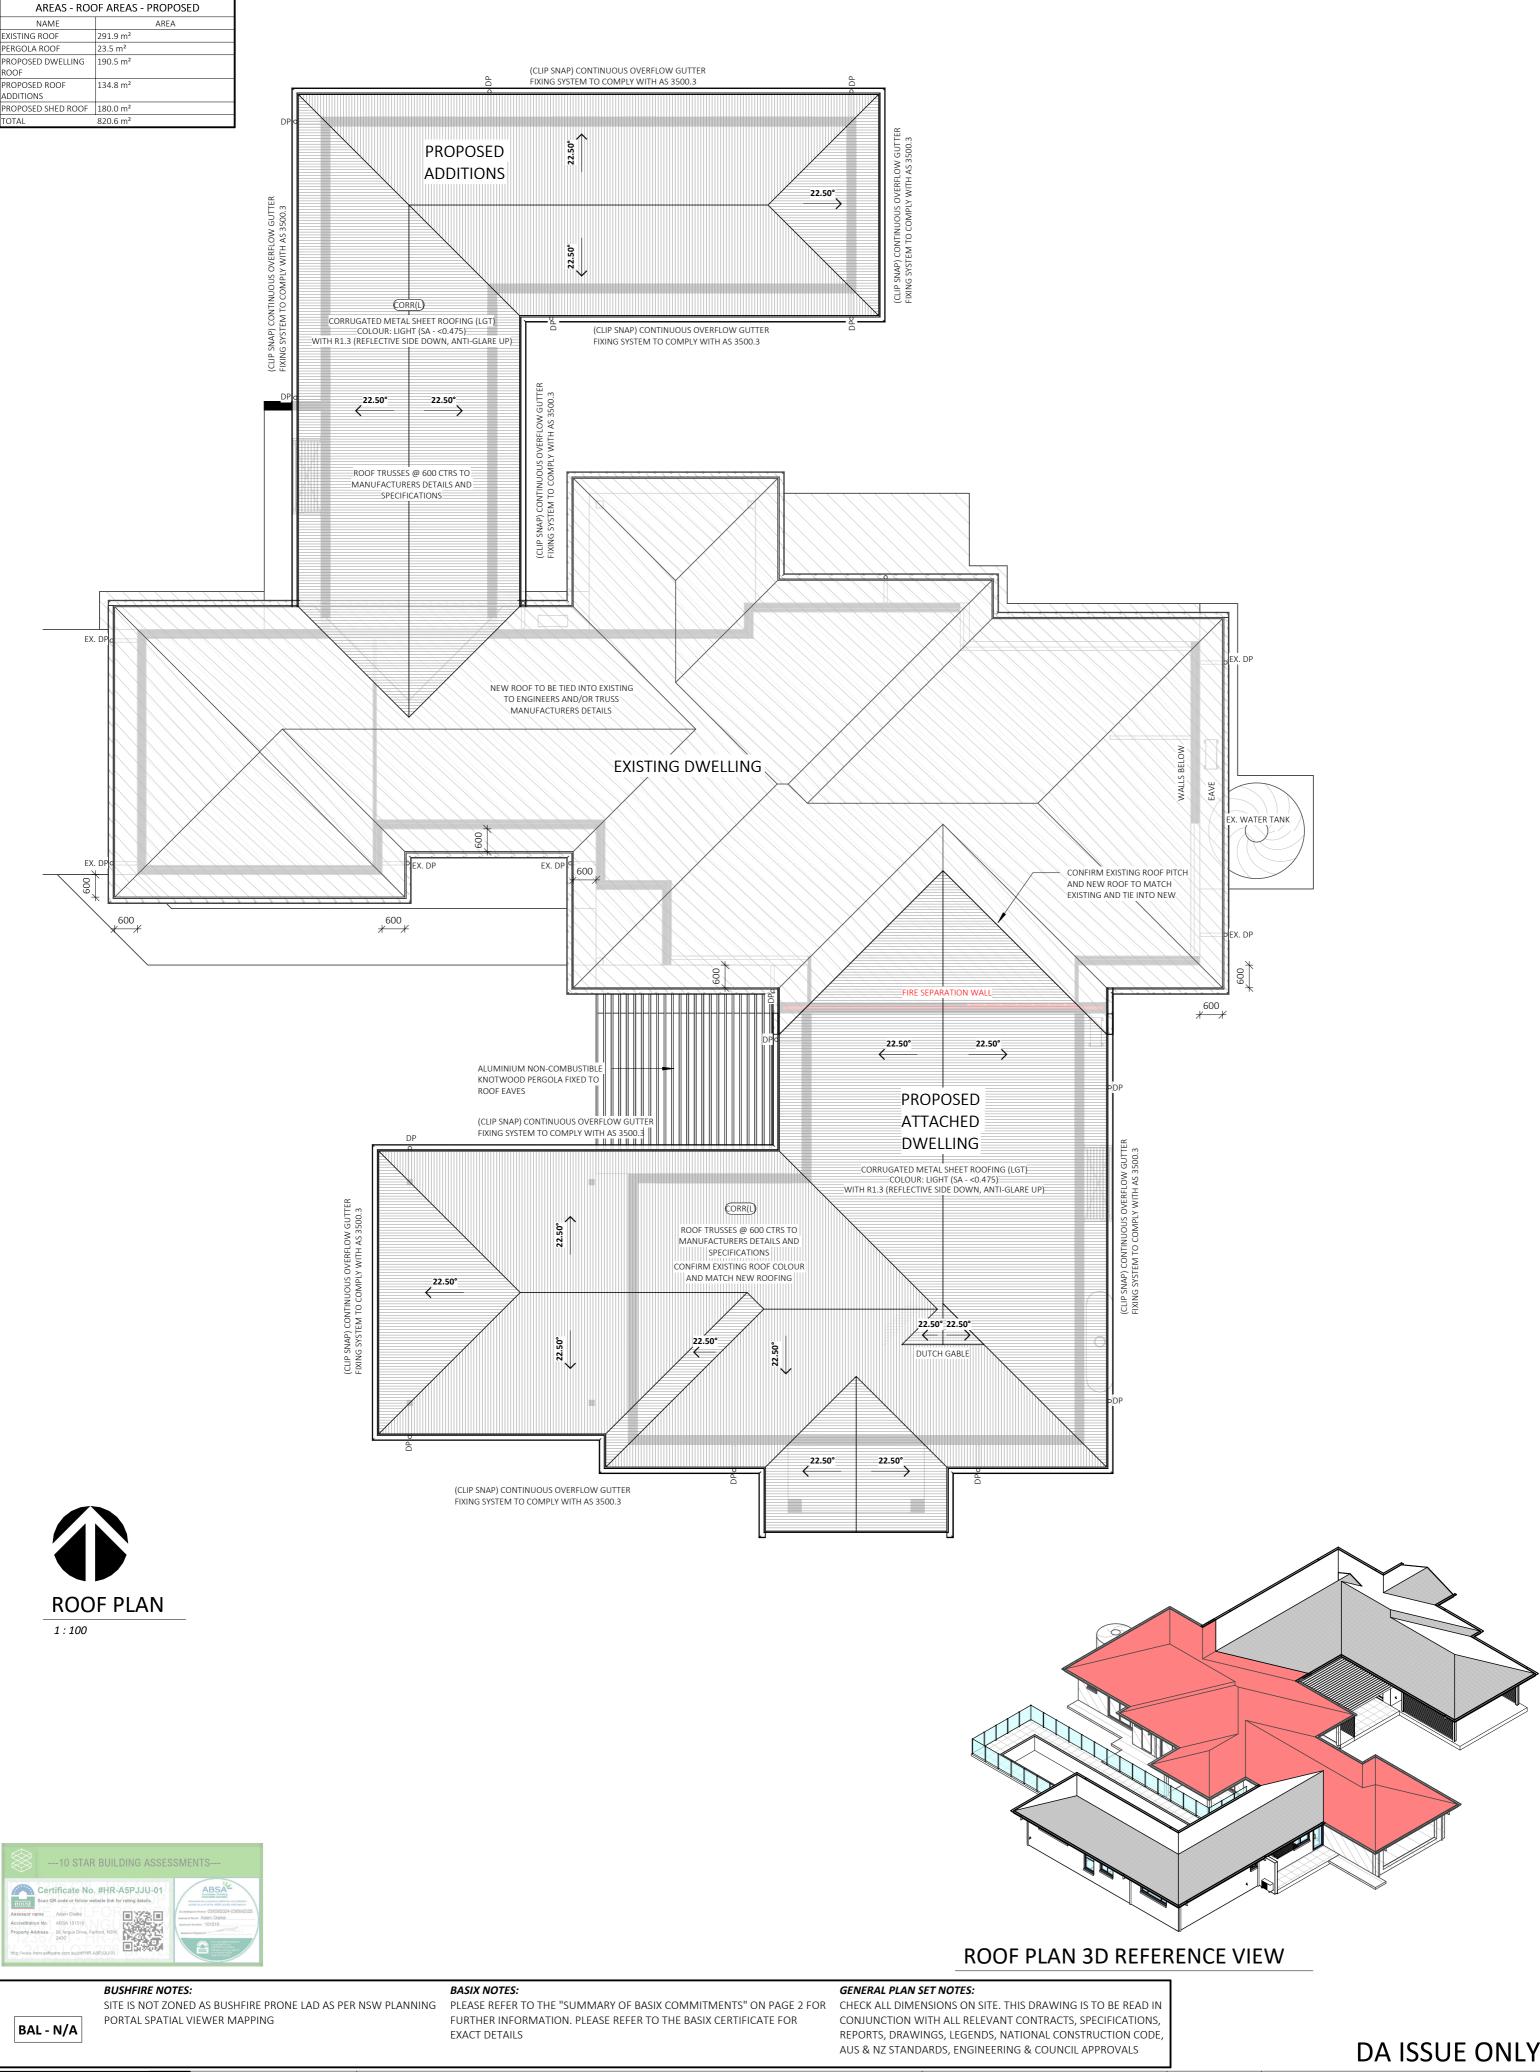
STATUS: DETAIL DESIGN LOT No: 206 STREET: 92 ANGUS DRIVE, FAILFORD 2430

ALTERATIONS & ADDITIONS TO AN EXISTING DWELLING AND PROPOSED ATTACHED DWELLING (NO S68 SERVICES PLAN PROJECT: SUBDIVISION) SHEET: 4 OF 21 SCALE: As indicated DP No: 1236728 START DATE: 09.01.2023 **CLIENT: BILLY McMAUGH** DWG No: A5682 9A Lord Street (PO Box 5667), Port Macquarie NSW 2444 | Shop 17 Centrepoint Arcade, Taree NSW 2430 T: 02 6583 441

DRAWING REVISIONS + NOTES SHEET SIZE: Date: Description: Issue: Drawn: 07.09.23 INITIAL ISSUE 20.05.24 FINAL CONCEPT 19.06.24 FINAL CONCEPT - REVISED

22.07.24 PRELIMINARY DA ISSUE Μ 10.09.24 SHED UPDATES



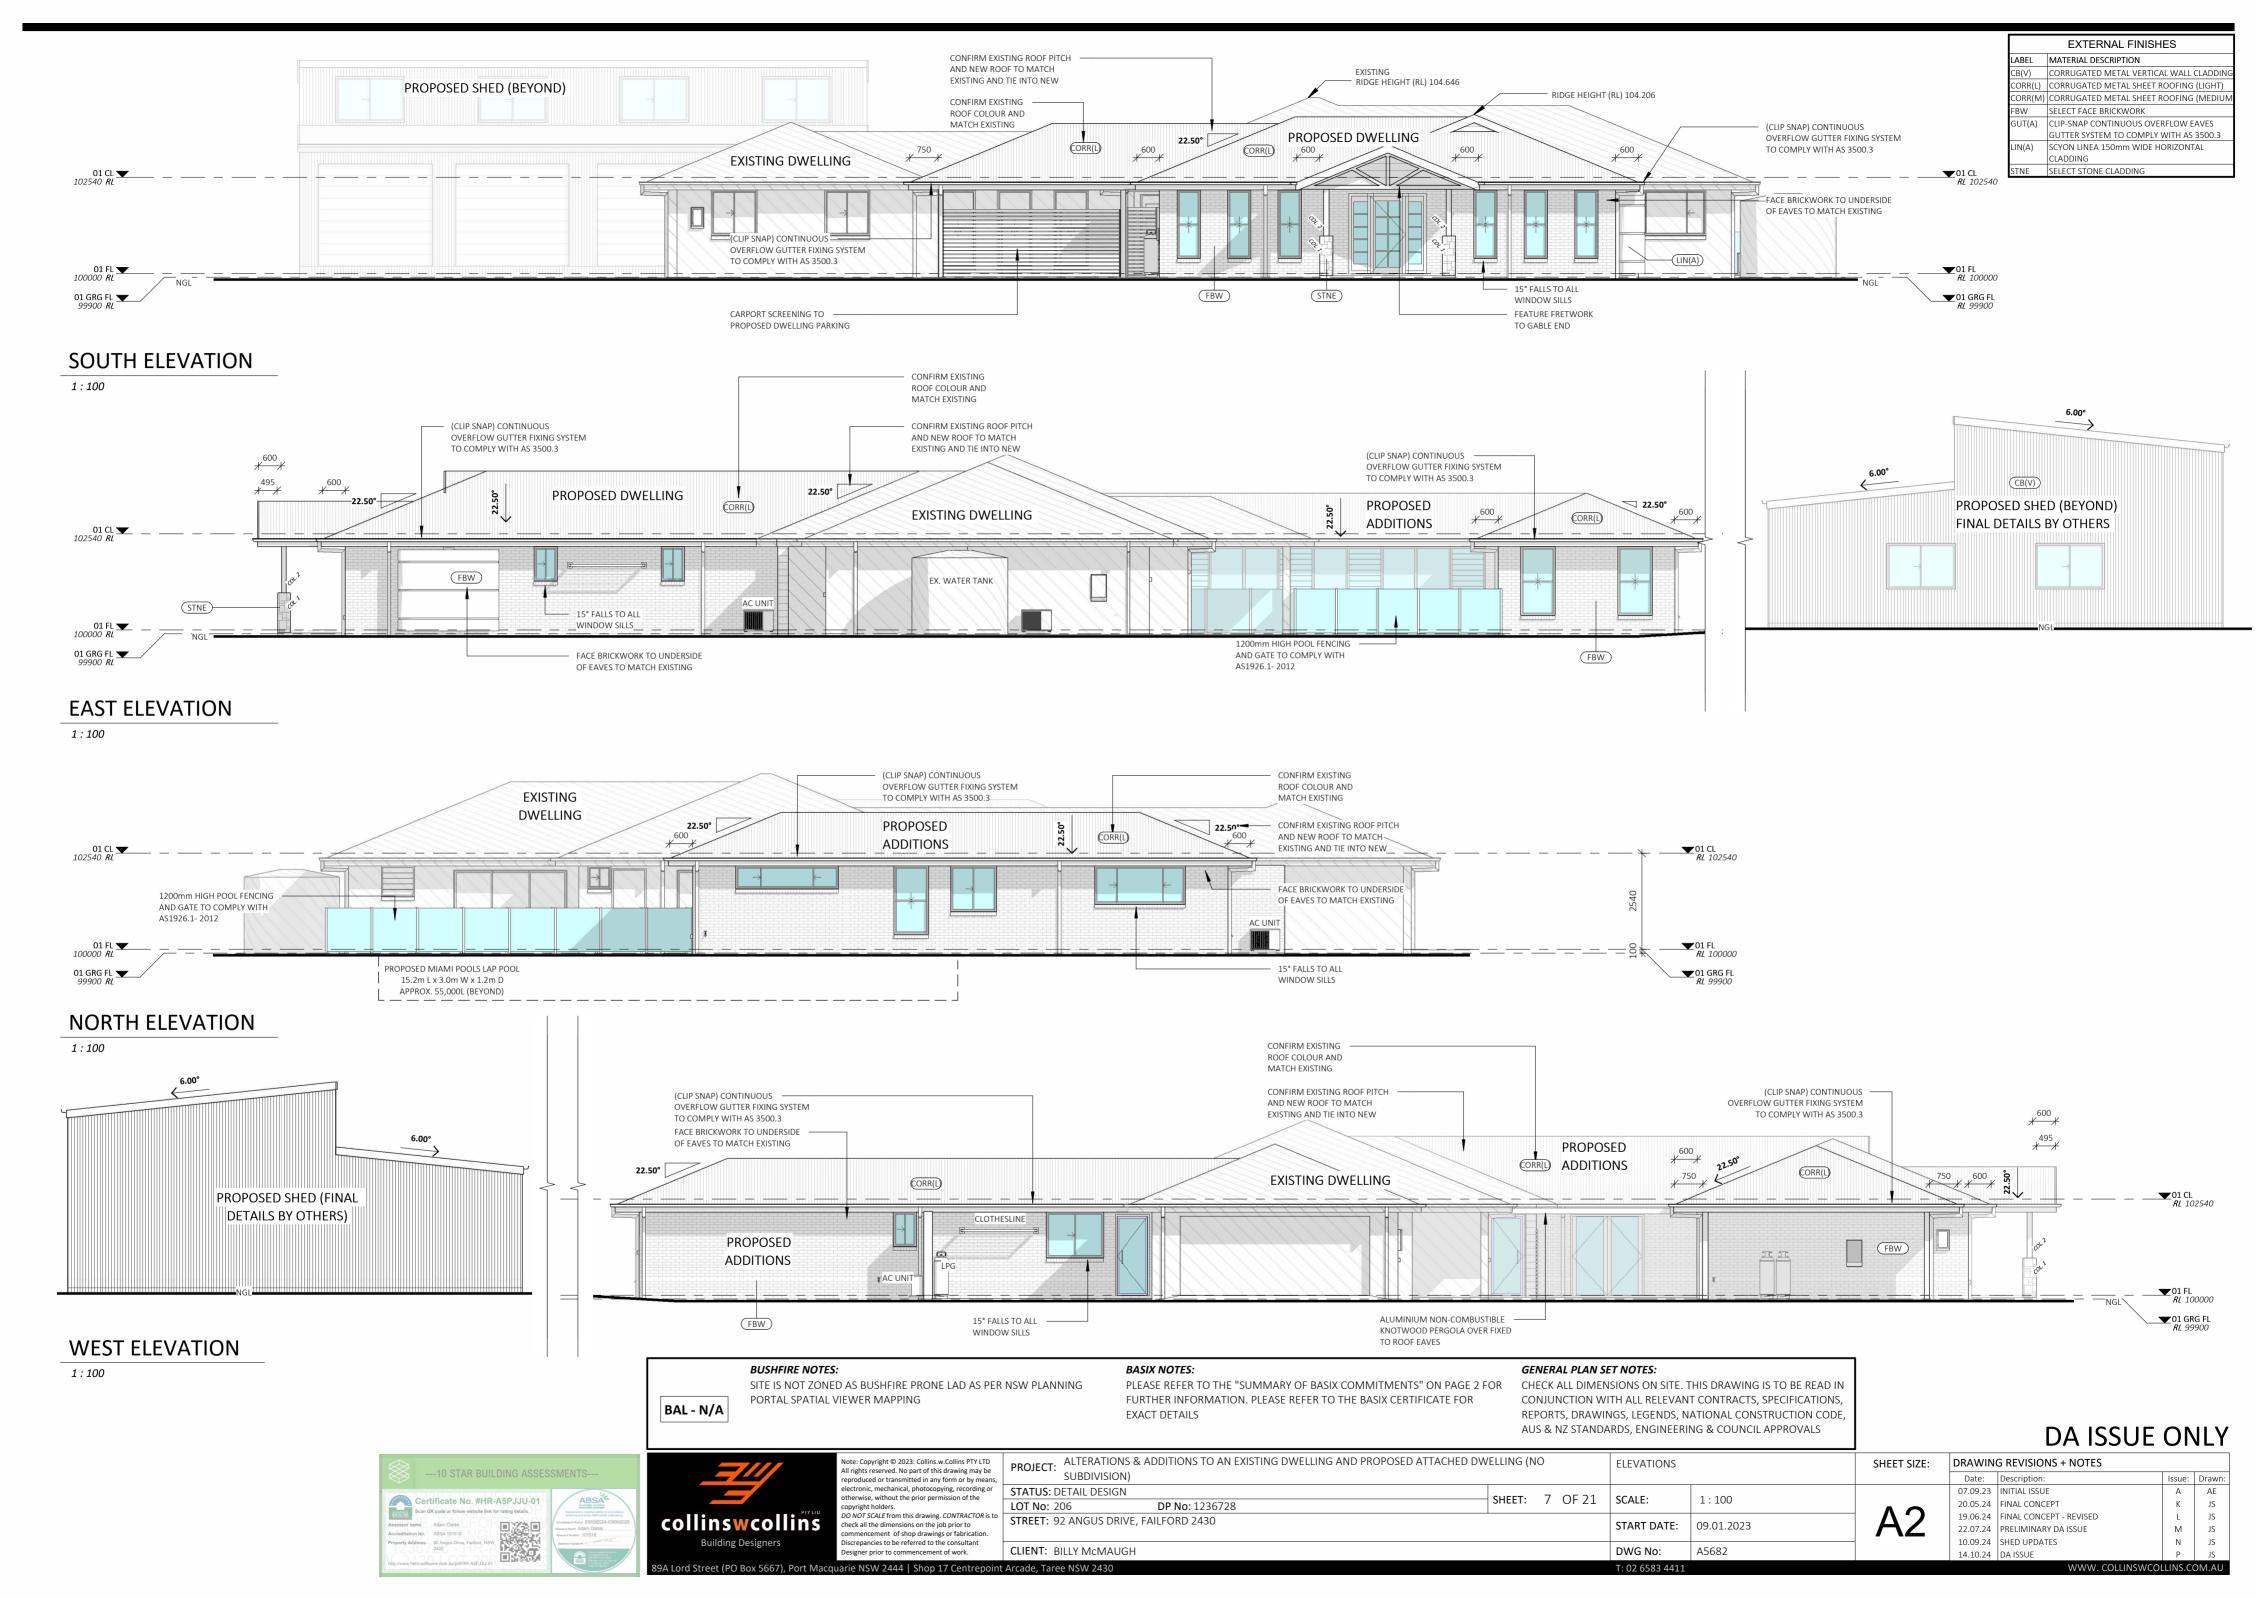


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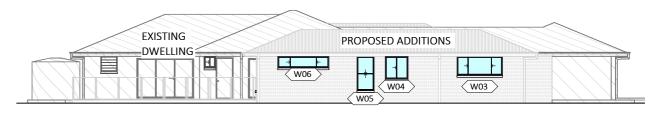
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JS JS

NUMBER	LEVEL	ROOM	HEIGHT	WIDTH	HEAD HEIGHT	TYPE	CONSTRUCTION	GLAZING	AREA
W01	01 FL	LAUNDRY	1200	1510	2210	SLIDING	ALUMINIUM	STANDARD	1.81 m²
W02	01 FL	POWDER	900	610	2210	SLIDING	ALUMINIUM	STANDARD	0.55 m <sup>2</sup>
W03	01 FL	RUMPUS	1000	2410	2210	SLIDING	ALUMINIUM	STANDARD	2.41 m <sup>2</sup>
W04	01 FL	ENS	1200	1210	2210	SLIDING	ALUMINIUM	STANDARD	1.45 m²
W05	01 FL	WIR	1800	910	2210	DOUBLE HUNG	ALUMINIUM	STANDARD	1.64 m²
W06	01 FL	MASTER (BED 1)	600	2710	2210	SLIDING	ALUMINIUM	STANDARD	1.63 m²
W07	01 FL	MASTER (BED 1)	1800	910	2210	DOUBLE HUNG	ALUMINIUM	STANDARD	1.64 m²
W08	01 FL	MASTER (BED 1)	1800	910	2210	DOUBLE HUNG	ALUMINIUM	STANDARD	1.64 m²
W10	01 FL	MASTER (BED 1)	1800	910	2210	LOUVRE	ALUMINIUM	STANDARD	1.64 m²
W11	01 FL	MASTER (BED 1)	1800	910	2210	FIXED GLASS	ALUMINIUM	STANDARD	1.64 m²
W12	01 FL	MASTER (BED 1)	1800	910	2210	FIXED GLASS	ALUMINIUM	STANDARD	1.64 m²
W13	01 FL	MASTER (BED 1)	1800	910	2210	LOUVRE	ALUMINIUM	STANDARD	1.64 m²
W14	01 FL	MASTER (BED 1)	1800	910	2210	FIXED GLASS	ALUMINIUM	STANDARD	1.64 m²
W15	01 FL	MASTER (BED 1)	1800	910	2210	LOUVRE	ALUMINIUM	STANDARD	1.64 m²
W16	01 FL	MASTER (BED 1)	1800	910	2210	FIXED GLASS	ALUMINIUM	STANDARD	1.64 m²
W17	01 FL	MASTER (BED 1)	1800	910	2210	FIXED GLASS	ALUMINIUM	STANDARD	1.64 m²
W18	01 FL	MASTER (BED 1)	1800	910	2210	LOUVRE	ALUMINIUM	STANDARD	1.64 m²
W19	01 FL	HALL	1800	910	2210	LOUVRE	ALUMINIUM	STANDARD	1.64 m²
W20	01 FL	HALL	1800	910	2210	FIXED GLASS	ALUMINIUM	STANDARD	1.64 m²
W21	01 FL	HALL	1800	910	2210	FIXED GLASS	ALUMINIUM	STANDARD	1.64 m²
W22	01 FL	HALL	1800	910	2210	LOUVRE	ALUMINIUM	STANDARD	1.64 m²
W23	01 FL	HALL	1800	910	2210	FIXED GLASS	ALUMINIUM	STANDARD	1.64 m²
W24	01 FL	HALL	1800	910	2210	LOUVRE	ALUMINIUM	STANDARD	1.64 m²
W25	01 FL	HALL	1800	910	2210	FIXED GLASS	ALUMINIUM	STANDARD	1.64 m²
W26	01 FL	HALL	1800	910	2210	FIXED GLASS	ALUMINIUM	STANDARD	1.64 m²
W27	01 FL	HALL	1800	910	2210	LOUVRE	ALUMINIUM	STANDARD	1.64 m²
			[	DOOR G	LAZING SC	CHEDULE			42.25 m <sup>2</sup>
NUMBER	LEVEL	ROOM	HEIGHT	WIDTH	HEAD HEIGHT	TYPE	CONSTRUCTION	GLAZING	AREA
D01	01 FL	BED 4	2100	820	2100	HINGED	ALUMINIUM	STANDARD	1.72 m²
D02	01 FL	HALL	2100	820	2100	HINGED	ALUMINIUM	STANDARD	1.72 m <sup>2</sup>

NOTE: GLAZING SIZES ARE INDICATIVE ONLY AND ARE SUBJECT TO MANUFACTURERS/SUPPLIES STANDARD TYPES AND SIZES




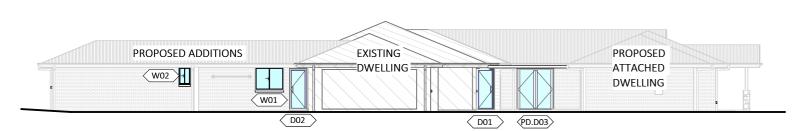

**NORTH GLAZING - PROPOSED ADDITIONS** 

#### WEST GLAZING - PROPOSED ADDITIONS

1:200

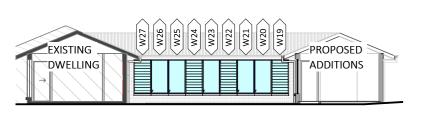

# **EAST GLAZING - PROPOSED ADDITIONS**

1:200

	MARY OF BASIX COMMITMENTS  RATIONS AND ADDITIONS TO THE	PROPOSED ATTACHED DWELLING
EXISTII	NG DWELLING	GLAZING NOTES AND SPECIFICATIONS:
THERM	IAL COMFORT REQUIREMENTS	WINDOWS SPECIFIED USE NFRC UW & SHGCW VALUES.
EXTERNAL WALLS	BRICK VENEER, R1.16 OR R1.70 INCLUDING CONSTRUCTION FRAMED, R1.30 OR R1.70 INCLUDING CONSTRUCTION	WINDOWS AS SPECIFIED OR EQUIVALENT MUST BE INSTALLED ON SITE
FLOORS	CONCRETE, ON GROUND, NO INSULATION	STANDARD GLAZING TO PROPOSED ATTACHED DWELLING:
CEILING	FLAT CEILING/PITCHED ROOF (>10°), R1.45 (UP)	REFER TO NATHERS CERTIFICATE FOR DETAILS AND REQUIREMENTS
ROOF	FLAT AND PITCHED ROOF, FRAMED AND UNVENTILATED, 55MM FOIL-BACKED BLANKET, COLOUR: MEDIUM (SA 0.475 – 0.70)	WEATHER STRIPPING TO BE INSTALLED THROUGHOUT.
SHADING	TYPICALLY 750mm INCLUDING FASCIA AND GUTTER	PLEASE NOTE: ALL GLAZING IN BATHROOMS, ENSUITES,
GLAZING	SINGLE CLEAR WITH ALUMINIUM FRAMES THROUGHOUT EXCEPT FOR EAST FACE GLAZING <i>W19-W27 (SINGLE, LOW-E)</i>	SPA ROOMS OR THE LIKE TO COMPLY WITH THE NCC, VOL. 2, H1D8 AND PART 8.4.6 OF ABCB HOUSING PROVISIONS
WATER	R COMMITMENTS	WINDOWS AND GLAZING TO COMPLY WITH:
	ALL NEW OR ALTERNED SHOWERHEADS, TOILETS OR TAPS 'E A MINIUM 3*STAR WATER RATING	AS 4055: WIND LOADS FOR HOUSING AS 1288: GLASS IN BUILDING - SELECTION & INSTALLATION
	G POOL: OUTDOORS/UNSHADED, MAX. VOLUME 55,000 LITRES, IG, NO COVER, PUMP ON TIMER	AS 2047: WINDOWS & EXTERNAL DOORS IN BUILDING AS 1170-Part 2: WIND ACTIONS
	R TANK AND CONNECTION: MIN. 2000L TANK COLLECTING 100m <sup>2</sup> REA. CONNECTION: TAP WITHIN 10m OF POOL EDGE	AS 3959: CONSTRUCTION OF BUILDINGS IN BUSHFIRE PRONE AREAS
ENERG	Y COMMITMENTS	*THE STANDARDS REFERRED ABOVE ARE THE VERSION
HWS:	EXISTING/UPGRADING EXISTING	ADOPTED BY THE NCC AT THE TIME THE RELEVANT
LIGHTING:	40% OF NEW OR ALTERED LIGHT FIXTURES ARE FITTED WITH FLUORESCENT, COMPACT FLUROESCENT OR LED LAMPS	CONSTRUCTION CERTIFICATE OR COMPLYING DEVELOPMENT CERTIFICATE APPLICATION IS MADE.



1:200

### **SOUTH GLAZING - PROPOSED ADDITIONS**

1:200



BAL - N/A

#### **BUSHFIRE NOTES:**

PORTAL SPATIAL VIEWER MAPPING

#### BASIX NOTES:

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## GENERAL PLAN SET NOTES:

SCALE:

START DATE:

T: 02 6583 4411

DWG No:

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Building Designers	Discrepancies to be refe
9 - 1 - 8 - 1	Designer prior to comm

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STATUS: DETAIL DESIGN LOT No: 206 **CLIENT:** BILLY McMAUGH

ALTERATIONS & ADDITIONS TO AN EXISTING DWELLING AND PROPOSED ATTACHED DWELLING (NO PROJECT: SUBDIVISION) SHEET: 11 OF 21 **DP No:** 1236728 STREET: 92 ANGUS DRIVE, FAILFORD 2430

EXISTING DWELLING GLAZING ADDITIONS As indicated 09.01.2023 A5682

DRAWING REVISIONS + NOTES SHEET SIZE: Date: Description: Issue: Drawn: 07.09.23 INITIAL ISSUE AE JS 20.05.24 FINAL CONCEPT 19.06.24 FINAL CONCEPT - REVISED JS JS 22.07.24 PRELIMINARY DA ISSUE Μ 10.09.24 SHED UPDATES

14.10.24 DA ISSUE

	DOOR GLAZING SCHEDULE (PROPOSED DWELLING)								
NUMBER	LEVEL	ROOM	HEIGHT	WIDTH	HEAD HEIGHT	TYPE	CONSTRUCTION	GLAZING	AREA
PD.D01	01 FL	PORCH	2050	920	2050	HINGED	ALUMINIUM	STANDARD	1.89 m <sup>2</sup>
PD.D02	01 FL	ALFRESCO	2100	3610	2100	SLIDING DOOR 4P	ALUMINIUM	STANDARD	7.58 m <sup>2</sup>
PD.D03	01 FL	ALFRESCO	2100	1840	2100	HINGED (DOUBLE)	ALUMINIUM	STANDARD	3.86 m <sup>2</sup>
					•				13 33 m <sup>2</sup>

NOTE: GLAZING SIZES ARE INDICATIVE ONLY AND ARE SUBJECT TO MANUFACTURERS/SUPPLIES STANDARD TYPES AND SIZES



SOUTH GLAZING - PROPOSED DWELLING

(PD.D02)

NORTH GLAZING - PROPOSED DWELLING

#### EAST GLAZING - PROPOSED DWELLING

(D.W10)

**(**D.W09)

**EXISTING** 

FRAME TYPE

ALM-SG-CLEAR


DWELLING

PROPOSED

ATTACHED

DWELLING

1:200

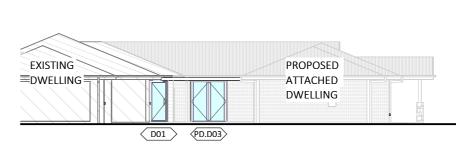

#### WEST GLAZING - PROPOSED DWELLING

VINDOW DESCRIPTION

SOLAR ABSORPTANCE

1:200

SUMMARY OF BASIX COMMITMENTS \*PROPOSED ATTACHED DWELLING THERMAL COMFORT REQUIREMENTS \*REFER TO NATHERS COMMITMENTS AND FINAL NATHERS CERTIFICATES FOR THERMAL RECUIREMENTS WATER COMMITMENTS HOWERHEADS: 4\* (>6 but <=7.5L/min) DIVIDUAL 3000 L INDVIDUAL ROOF 100m<sup>2</sup>
ATER TANK: COLLECTION : COLD WATER TAP IN THE LAUNDRY AT LEAST 1 EXTERNAL TAP FOR DEDICATED LAND NONE REQUIRED **ENERGY COMMITMENTS** GAS INSTANTANEOUS - MIN. 5\* STAR ALL ROOMS ARE TO BE PRIMARILY LIT BY FLUORES OR LED DEDICATED FITTINGS NONE REQUIRED

#### PROPOSED ATTACHED DWELLING

#### GLAZING NOTES AND SPECIFICATIONS:

WINDOWS SPECIFIED USE NFRC UW & SHGCW VALUES. WINDOWS AS SPECIFIED OR EQUIVALENT MUST BE

NSTALLED ON SITE

STANDARD GLAZING TO PROPOSED ATTACHED DWELLING: REFER TO NATHERS CERTIFICATE FOR DETAILS AND REQUIREMENTS

WEATHER STRIPPING TO BE INSTALLED THROUGHOUT.

PLEASE NOTE: ALL GLAZING IN BATHROOMS, ENSUITES,

SPA ROOMS OR THE LIKE TO COMPLY WITH THE NCC, VOL H1D8 AND PART 8 4 6 OF ABCB HOUSING PROVISIONS

WINDOWS AND GLAZING TO COMPLY WITH:

AS 4055 : WIND LOADS FOR HOUSING AS 1288 : GLASS IN BUILDING - SELECTION & INSTALLATION AS 2047: WINDOWS & EXTERNAL DOORS IN BUILDING AS 1170-Part 2: WIND ACTIONS AS 3959: CONSTRUCTION OF BUILDINGS IN BUSHFIRE

PRONE AREAS \*THE STANDARDS REFERRED ABOVE ARE THE VERSION ADOPTED BY THE NCC AT THE TIME THE RELEVANT CONSTRUCTION CERTIFICATE OR COMPLYING DEVELOPMENT CERTIFICATE APPLICATION IS MADE.

0.69



10 Star Building Assessments Myrtle Street, Botany, NSW, 2019 admin@10sba.com www.10sba.com 048 1010 999

OTHER INFORMATION

#### NaTHERS REQUIREMENTS PLAN STAMP - 549.0 ESD-NAT-230724-FAILFORD

NaTHERS requirements set out below are part of the requirements to achieve final occupation certification.

Any items that are changed or altered require a new NatHERS certificate to be issue:

Compliance with this is required to be demonstrated upon completion to the certifying authority. The Certifier must confirm that these commitments have been installed and not altered.

#### PROJECT DETAILS

ADDRESS	SUBURB / TOY	VN / POST CODE	LOT # DP#	
92 Angus Drive	Failford		Lot 206 DP 1236728	
ENERGY RATING	79			
STAR RATING	DWELLING #	HEATING LOAD	COOLING LOADS	

STAR RATING	DWELLING #	HEATING LOAD	COOLING LOADS
7	Secondary dwelling	29.8	21.1

#### **FLOORS**

FLOOR TYPE

1:200

1:200

PROPOSED

ATTACHED

**DWELLING** 

AREA	COVERING	OTHER INFORMATION
FLOOR COVERINGS	7	
85mm Waffle pod slab	175mm Pods	11

ADDITIONAL INSULATION

AREA	COVERING.	OTHER INFORMATION
As per plans	N/A	
	W	7

#### WALL INSULATION

INTERNAL / EXTERNAL	WALL TYPE	ADDITIONAL INSULATION	OTHER INFORMATION
EXTERNAL	Brick Veneer - Non reflective cav	R2.0	
INTERNAL	PB PB	R1.50	Walls shared with Bed 1 ens.

SOLAR ABSORPTANCE Medium (0.475-0.70)

#### **ROOF AND CEILINGS**

ROOF CONSTRUCTION TYPE	INSULATION	OTHER INFORMATION	
Metal	R1.3 foil back blanket	3	
SOLAR ABSORPTANCE	(assumed surfmist)		
CEILING TYPE	INSULATION	OTHER INFORMATION	
Ceiling shared with external areas	R3.50	-	

#### WINDOWS AND GLAZING

WINDOW DESCRIPTION	FRAME TYPE	U VALUE	SHGC	
DOuble hung	ALM-SG-CLEAR	6.08	0.68	
Fixed	ed ALM-SG-CLEAR		0.68	
Slifting	ALM-SG-CLEAR	6.29	0.68	
Hinged door ALM-SG-CLEAR		6.70	0.57	

NaTHERS REQUIREMENTS PLAN STAMP - 549.0 ESD-NAT-230724-FAILFORD Page 1 **CEILING FANS - EXHAUST FANS** AREA TYPE

Medium (0.475-0.70)

CEILING FAN 1200 Dia Min Bedrooms EXHAUST FAN Max 150 x 150 pentiration. Fan to be sealed Ensuites and Kitchen **EXHAUST FAN** Max 250 x 250 pentiration. Fan to be sealed

U VALUE

6.16

#### LIGHTING

Sliding door

DESCRIPTION	OTHER INFORMATION
1 recessed d / light per 5 sqm	Downlights to be sealed and assumed equivalent a halogen 40 watt globe



NaTHERS REQUIREMENTS PLAN STAMP - 549.0 ESD-NAT-230724-FAILFORD

Version: 10

# collinswcollins

BAL - N/A

**BUSHFIRE NOTES:** 

PORTAL SPATIAL VIEWER MAPPING

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Version: 10

BASIX NOTES:

**GENERAL PLAN SET NOTES:** CHECK ALL DIMENSIONS ON SITE. THIS DRAWING IS TO BE READ IN CONJUNCTION WITH ALL RELEVANT CONTRACTS, SPECIFICATIONS, REPORTS, DRAWINGS, LEGENDS, NATIONAL CONSTRUCTION CODE,


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DA ISSUE ONLY

DRAWING REVISIONS + NOTES SHEET SIZE: Date: Description: Issue: Drawn: 07.09.23 INITIAL ISSUE 20.05.24 FINAL CONCEPT 19.06.24 FINAL CONCEPT - REVISED JS 22.07.24 PRELIMINARY DA ISSUE Μ 10.09.24 SHED UPDATES


ALTERATIONS & ADDITIONS TO AN EXISTING DWELLING AND PROPOSED ATTACHED DWELLING (NO PROPOSED DWELLING GLAZING PROJECT: SUBDIVISION) **STATUS**: DETAIL DESIGN SHEET: 12 OF 21 SCALE: As indicated LOT No: 206 DP No: 1236728 STREET: 92 ANGUS DRIVE, FAILFORD 2430 START DATE: 09.01.2023 **CLIENT: BILLY McMAUGH** DWG No: A5682



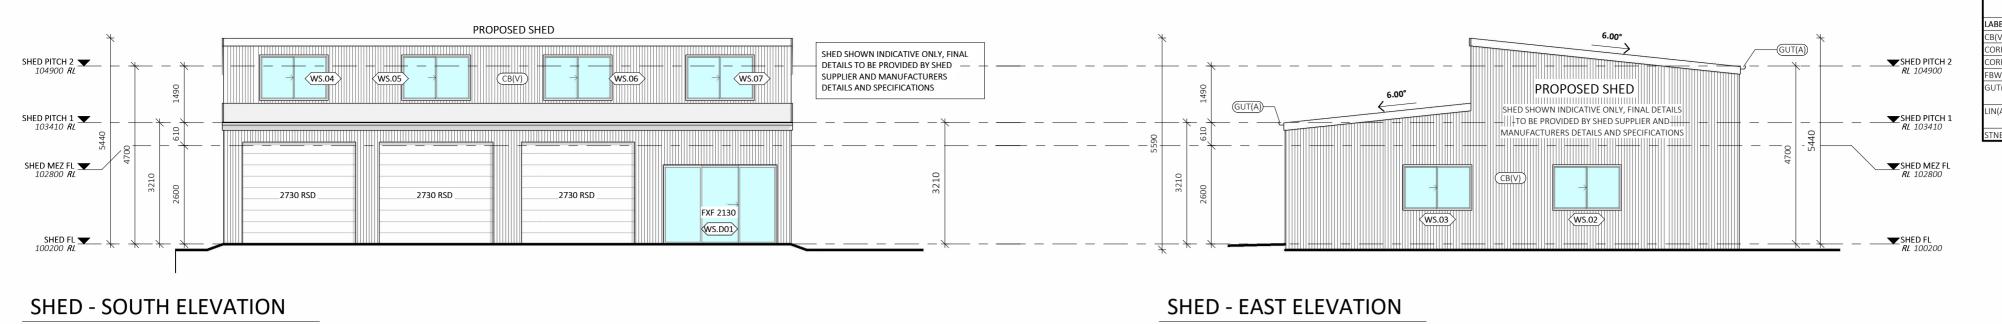


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1:100

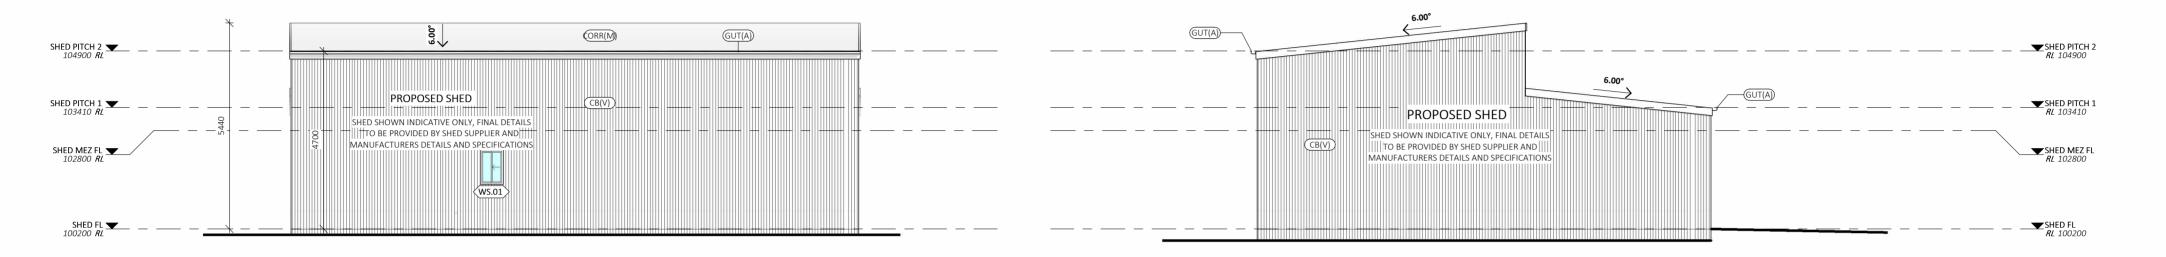

#### **SHED - NORTH ELEVATION**

1:100

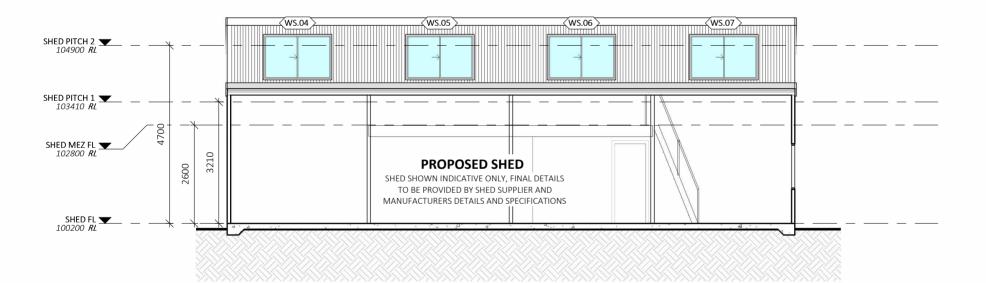

#### SHED - WEST ELEVATION

1:100


WINDOW GLAZING SCHEDULE - SHED									
NUMBER	LEVEL	ROOM	HEIGHT	WIDTH	HEAD HEIGHT	TYPE	CONSTRUCTION	GLAZING	AREA
WS.01	SHED FL		900	610	2100	SLIDING	ALUMINIUM	STANDARD	0.55 m <sup>2</sup>
WS.02	SHED FL	PROPOSED SHED	1200	1810	2100	SLIDING	ALUMINIUM	STANDARD	2.17 m <sup>2</sup>
WS.03	SHED FL	PROPOSED SHED	1200	1810	2100	SLIDING	ALUMINIUM	STANDARD	2.17 m <sup>2</sup>
WS.04	SHED MEZ FL	PROPOSED SHED	1200	1810	2400	SLIDING	ALUMINIUM	STANDARD	2.17 m <sup>2</sup>
WS.05	SHED MEZ FL	PROPOSED SHED	1200	1810	2400	SLIDING	ALUMINIUM	STANDARD	2.17 m <sup>2</sup>
WS.06	SHED MEZ FL	PROPOSED SHED	1200	1810	2400	SLIDING	ALUMINIUM	STANDARD	2.17 m <sup>2</sup>
WS.07	SHED MEZ FL	PROPOSED SHED	1200	1810	2400	SLIDING	ALUMINIUM	STANDARD	2.17 m <sup>2</sup>
									13.58 m²

DOOR GLAZING SCHEDULE - SHED NUMBER LEVEL ROOM HEIGHT CONSTRUCTION GLAZING AREA WS.D01 SHED FL PROPOSED SHED 2100 SLIDING DOOR 3P **ALUMINIUM** STANDARD 6.30 m<sup>2</sup> 3000

#### **SHED SECTION A-A**

1:100

# NOTE: SHED SHOWN INDICATIVE ONLY AND SUBJECT TO SHED SUPPLIERS AND MANUFACTURERS DETAILS AND SPECIFICATIONS

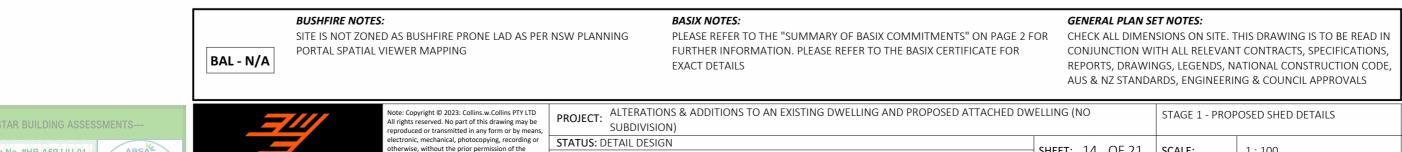


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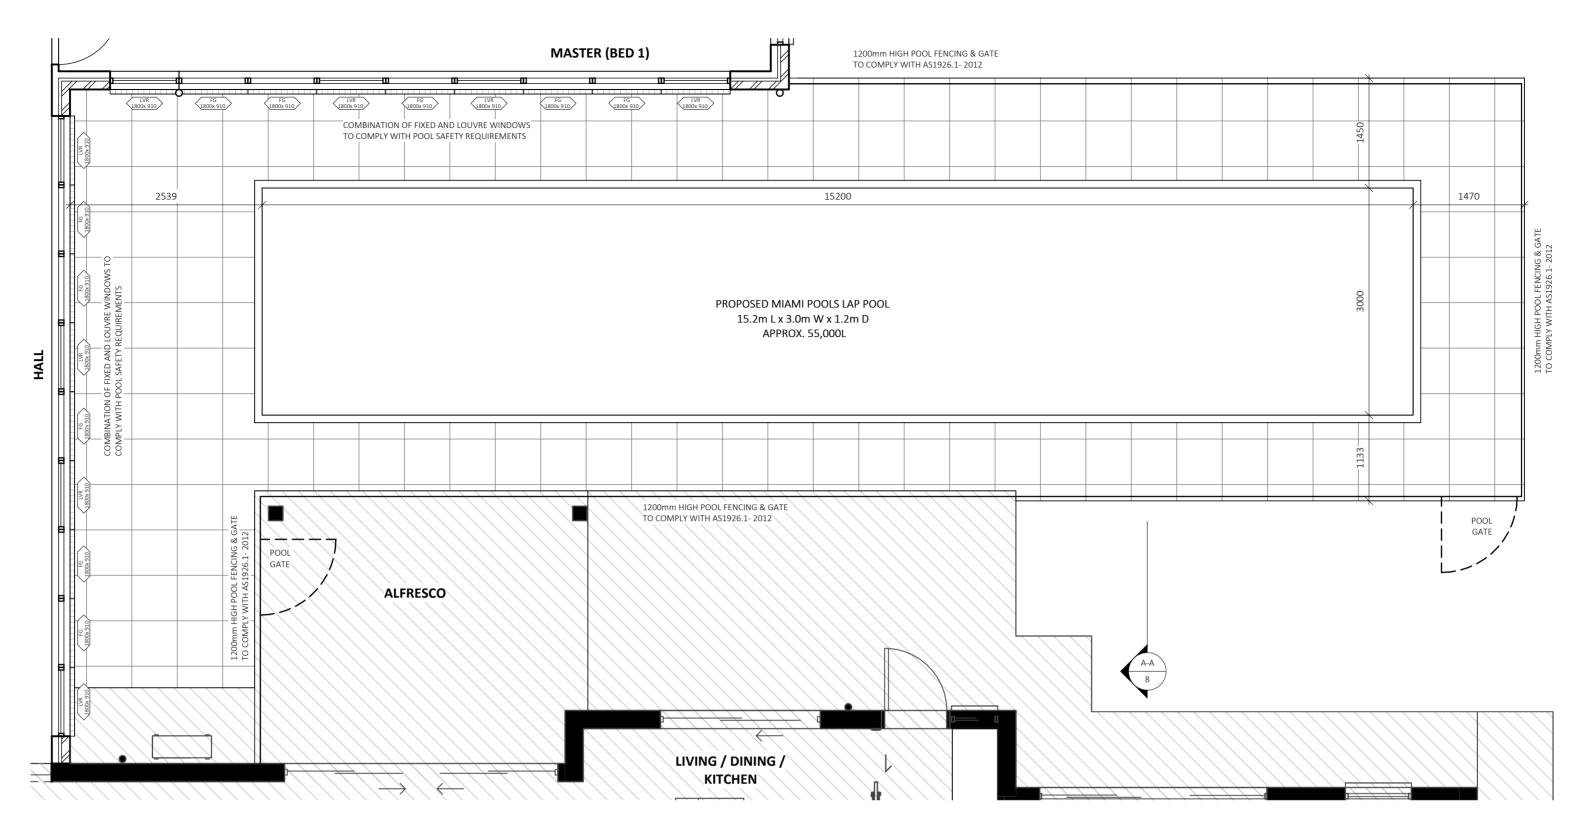
mmencement of shop drawings or fabrication

repancies to be referred to the consultant igner prior to commencement of work.


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BAL - N/A

**BUSHFIRE NOTES:** SITE IS NOT ZONED AS BUSHFIRE PRONE LAD AS PER NSW PLANNING PORTAL SPATIAL VIEWER MAPPING

PLEASE REFER TO THE "SUMMARY OF BASIX COMMITMENTS" ON PAGE 2 FOR FURTHER INFORMATION. PLEASE REFER TO THE BASIX CERTIFICATE FOR **EXACT DETAILS** 
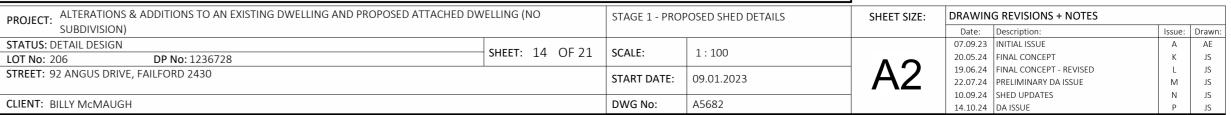
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PROJECT: ALTERATIONS & ADDITIONS TO AN EXISTING DWELLING AND PROPOSED ATTACHED DWELLING (NO SUBDIVISION) STATUS: DETAIL DESIGN LOT No: 206 DP No: 1236728 **STREET:** 92 ANGUS DRIVE, FAILFORD 2430 **CLIENT:** BILLY McMAUGH


STAGE 3 - PROPOSED POOL DETAILS SHEET SIZE: SHEET: 15 OF 21 | SCALE: 1:50 **START DATE**: 09.01.2023 DWG No: A5682

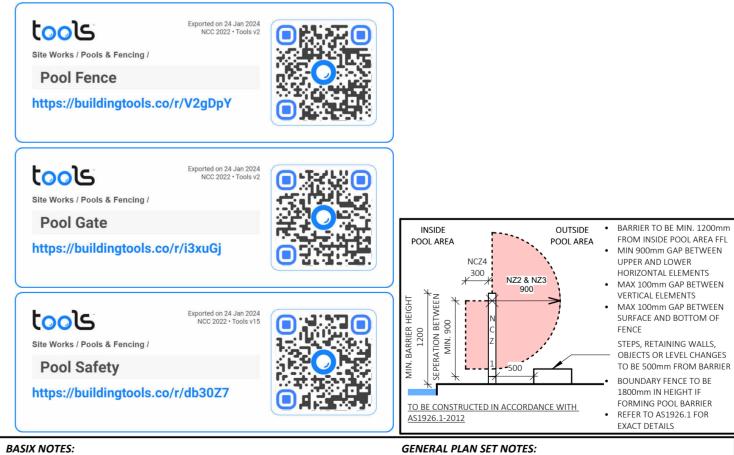07.09.23 INITIAL ISSUE 20.05.24 FINAL CONCEPT 22.07.24 PRELIMINARY DA ISSUE 10.09.24 SHED UPDATES 14.10.24 DA ISSUE

DRAWING REVISIONS + NOTES Date: Description: 19.06.24 FINAL CONCEPT - REVISED






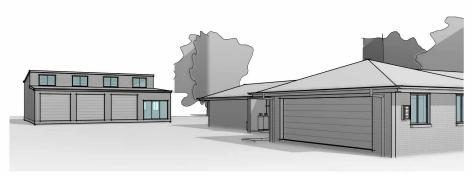





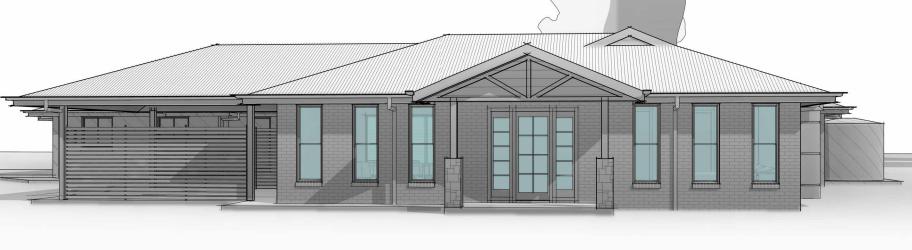

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#### **BUSHFIRE NOTES:**

BAL - N/A

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#### BASIX NOTES:

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#### GENERAL PLAN SET NOTES:

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PROJECT: ALTERATIONS & ADDITIONS TO AN EXISTING DWELLING AND PROPOSED ATTACHED DWELLING (NO SUBDIVISION)		3D VIEWS AND PERSPECTIVES		DRAWING REVISION + NOTES				
				Date:	Revision:	Issue:	Drawn:	
STATUS: DETAIL DESIGN	CULLET. 1C OF 31	SCALE:		20.05.24	FINAL CONCEPT	K	JS	
LOT No: 206 DP No: 1236728	SHEET: 16 OF 21			19.06.24	FINAL CONCEPT - REVISED	L	JS	
STREET: 92 ANGUS DRIVE, FAILFORD 2430	SHEET SIZE:	A3	22.07.24	PRELIMINARY DA ISSUE	М	JS		
• · · · · · · · · · · · · · · · · · · ·	START DATE:	09.01.2023	10.09.24	SHED UPDATES	N	JS		
CLIENT: BULLYAA AAALIGU		DIA/C N	45600	14.10.24	DA ISSUE	P	JS	
CLIENT: BILLY McMAUGH		DWG No:	A5682					

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